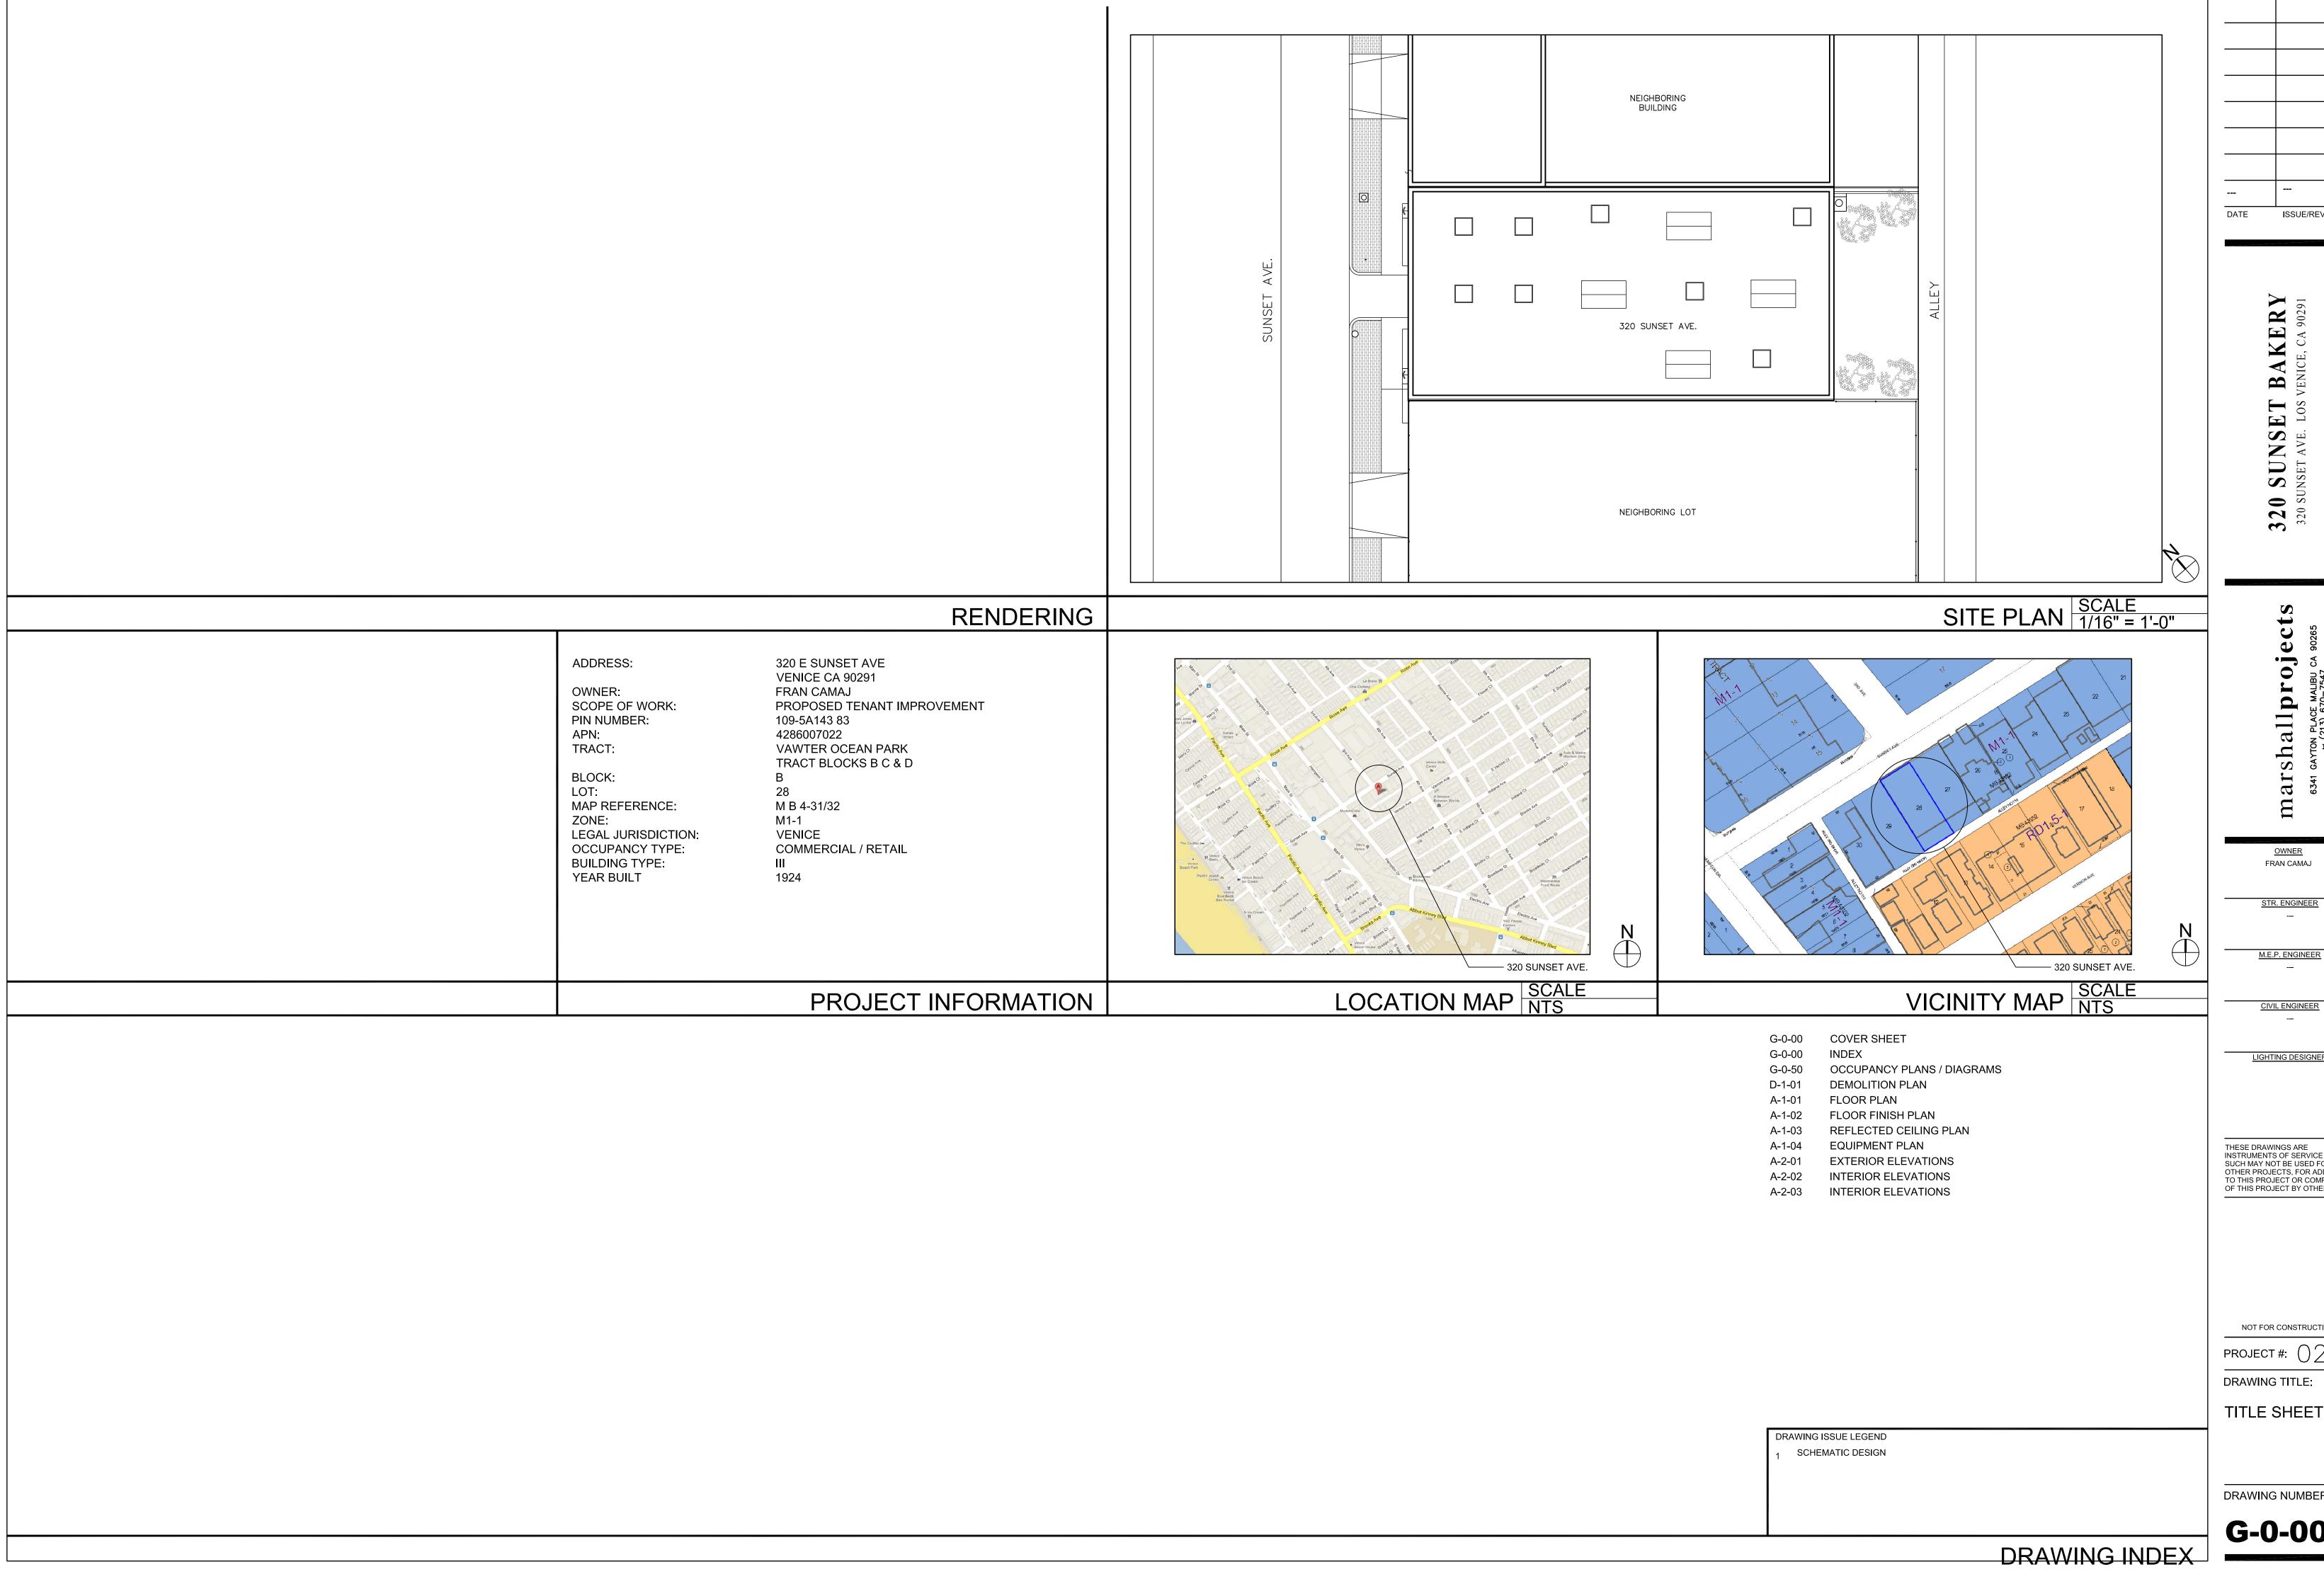
320 SUNSET AVE.

I.D. SET
MARCH 06, 2013

marshall projects

6341 GAYTON PLACE MALIBU CA 90265

(213) 670-7547



ISSUE/REVISION

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6341 GAYTON PLACE MALIBU CA 90265

<u>OWNER</u> FRAN CAMAJ

LIGHTING DESIGNER

THESE DRAWINGS ARE
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OTHER PROJECTS, FOR ADDITIONS
TO THIS PROJECT OR COMPLETION
OF THIS PROJECT BY OTHERS.

NOT FOR CONSTRUCTION

PROJECT #: 028 DRAWING TITLE:

TITLE SHEET

DRAWING NUMBER:

G-0-00

320 SUNSET AVE. LOS V

LIGHTING DESIGNER

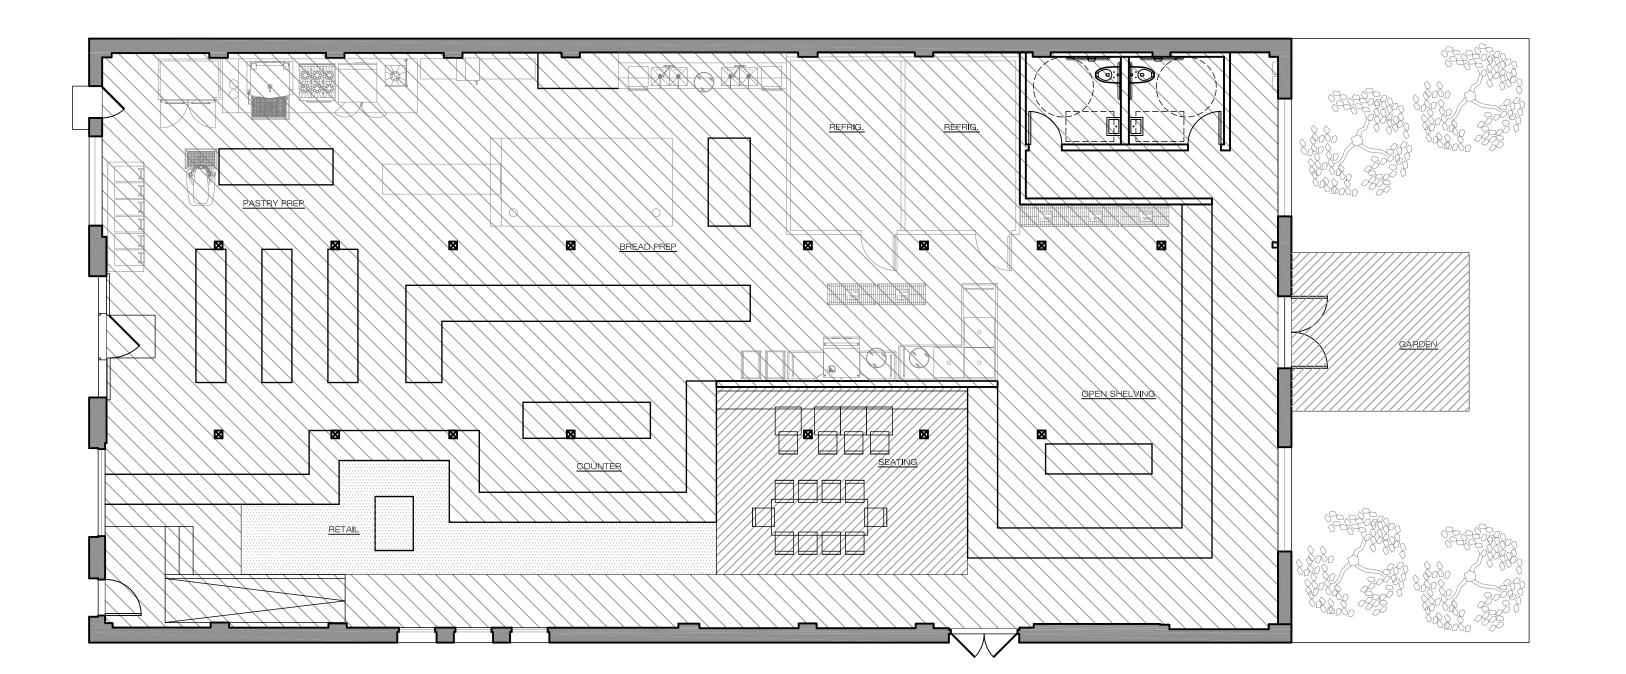
project #: 028

Drawing title:

DEMO FLOOR PLAN

DRAWING NUMBER:

G-0-50



PROPOSED PARKING SUMMARY (FOR SUBJECT AREA):

EXISTING SQUARE FOOTAGE = 4,675 SQ. FT PROPOSED SQUARE FOOTAGE = 4,675 SQ. FT

320 SUNSET AVE:

PROPOSED RETAIL: 232 SQ. FT = 1.03 SPACES (232 / 225 = 1.03)

PROPOSED BAKERY AREA: = (4116.2 / 500 = 8.23)

PROPOSED SERVICE FLOOR AREA = 10.46 SPACES (523.15 / 50 = 10.46)

REQUIRED = 20 SPACES (E) SPACES = 20 SPACES

PROPOSED SERVICE AREA: (1:50)

BAKERY AREA:

RETAIL AREA:

PARKING CALCULATION DIAGRAM | SCALE | 1/8" = 1'-0"

OCCUPANT LOAD CALCULATIONS FOR PROPOSED USE OF STRUCTURE:

320 SUNSET AVE:
PROPOSED SERVICE AREA (1:15) = 523/15 = 34.9 TOTAL
PROPOSED RETAIL AREA (1:100) = 232/100 = 2.3 TOTAL
PROPOSED BAKERY (KITCHEN) (1:200) = 2,300/200 = 11.5 TOTAL
PROPOSED BAKERY STORAGE (1:300) = 853/300 = 2.84 TOTAL
PROPOSED OTHER USES (1:300) =963/300 = 3.21 TOTAL

=55 OCCUPANTS TOTAL

PROPOSED SERVICE AREA (ASSEMBLY): (1:15)


RETAIL (BUSINESS): (1:100)

BAKERY (COMMERCIAL KITCHEN): (1:200)

BAKERY STORAGE (MERCANTILE): (1:300)

OTHER USES "BATHROOMS, STORAGE, ETC.": (1:100)

OCCUPANCY CALCUALTION DIAGRAM | SCALE | 1/8" = 1'-0"

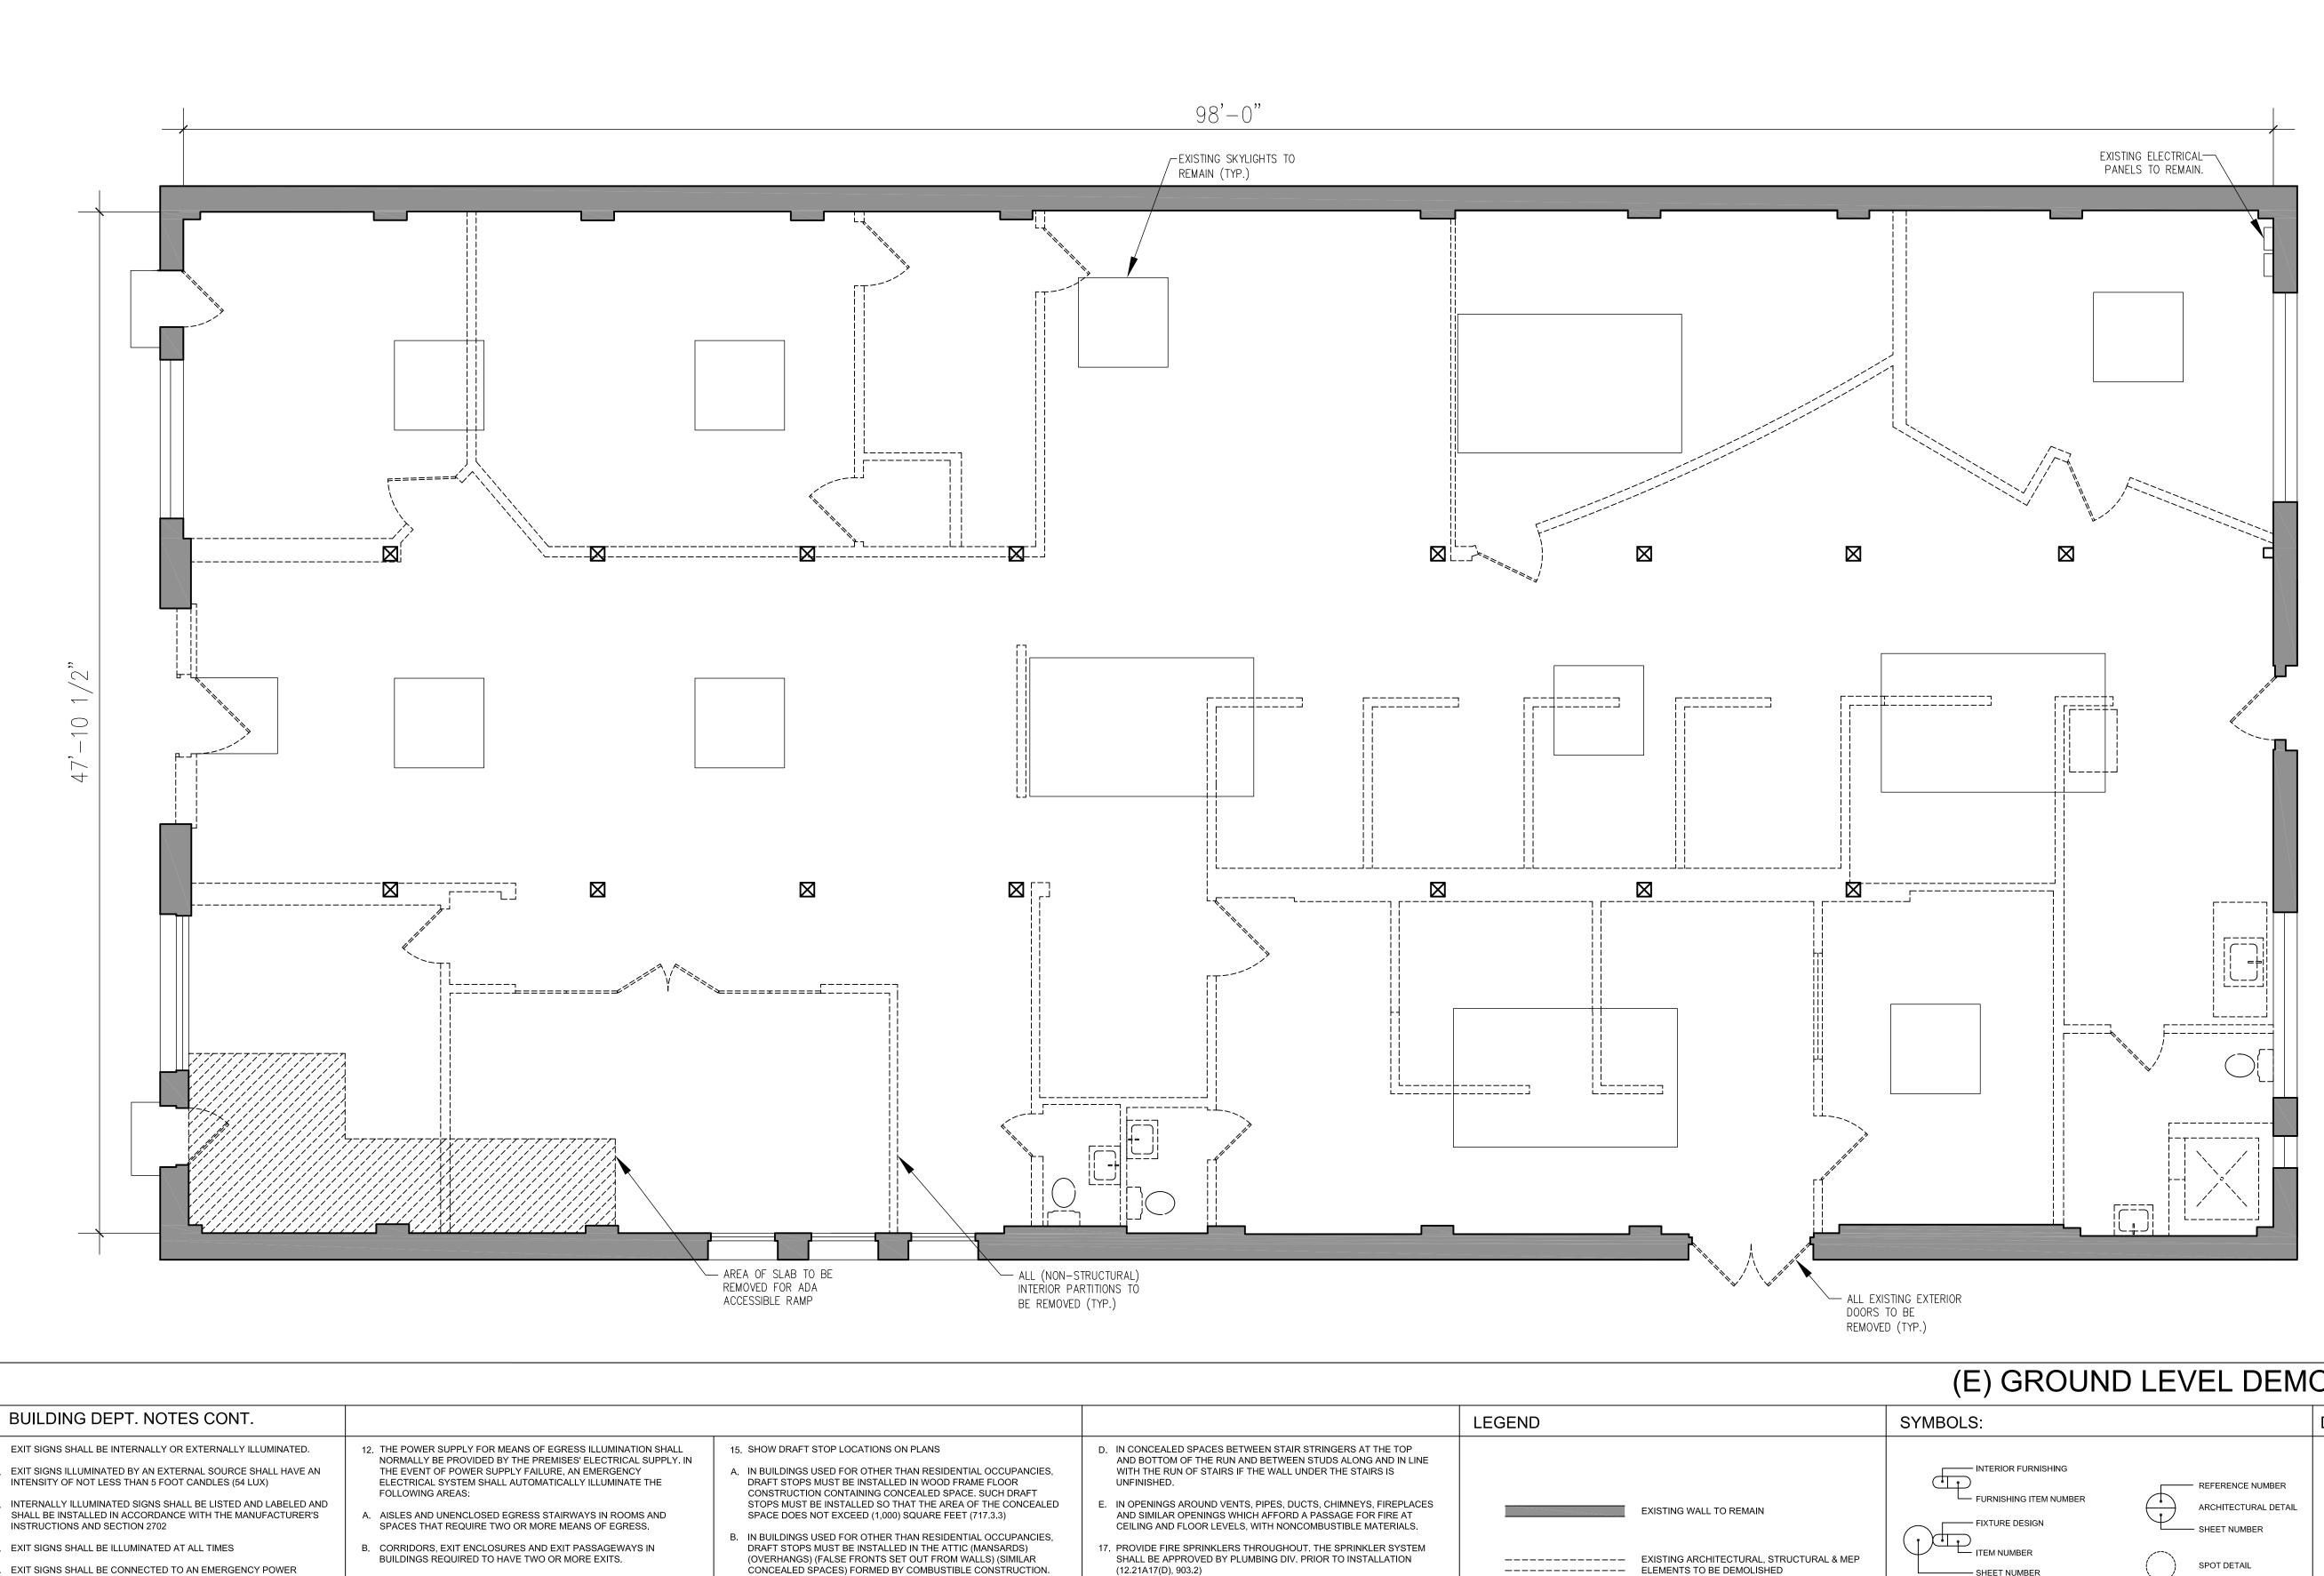

(E) GROUND LEVEL DEMOLITION PLAN | SCALE | 1/4" = 1'-0" OF THIS PROJECT BY OTHERS. DEMOLITION NOTES:

MATERIALS RESULTING FROM DEMOLITION OPERATIONS.

NO COST TO THE OWNER.

REQUIRED FOR NEW WORK.

1. EXIT SIGNS SHALL BE INTERNALLY OR EXTERNALLY ILLUMINATED. 2. EXIT SIGNS ILLUMINATED BY AN EXTERNAL SOURCE SHALL HAVE AN

- 3. INTERNALLY ILLUMINATED SIGNS SHALL BE LISTED AND LABELED AND
- 4. EXIT SIGNS SHALL BE ILLUMINATED AT ALL TIMES

MIN. IN CASE OF PRIMARY POWER LOSS.

- 5. EXIT SIGNS SHALL BE CONNECTED TO AN EMERGENCY POWER SYSTEM THAT WILL PROVIDE AN ILLUMINATION OF NOT LESS THAN 90
- 6. EGRESS DOORS SHALL BE READILY OPENABLE FROM THE EGRESS SIDE WITHOUT THE USE OF A KEY OR SPECIAL KNOWLEDGE OR
- 7. DOOR HANDLES, LOCK AND OTHER OPERATING DEVICES SHALL BE
- INSTALLED AT A MIN. 34" AND A MAX. 48" ABOVE THE FINISHED FLOOR. 8. THIS DOOR TO REMAIN UNLOCKED WHEN BUILDING IS OCCUPIED
- 9. ALL EGRESS DOOR OPERATION SHALL ALSO COMPLY WITH SECTION
- 1008.1.9-1008.1.9.7 10. THE MEANS OF EGRESS, INCLUDING EXIT DISCHARGE, SHALL BE ILLUMINATED AT ALL TIMES THE BUILDING SPACE SERVED BY THE
- MEANS OF EGRESS IS OCCUPIED.
- 11. THE MEANS OF EGRESS ILLUMINATION LEVEL SHALL NOT BE LESS THAN 1 FOOT-CANDLE AT THE WALKING SURFACE.
- C. EXTERIOR EGRESS COMPONENTS AT OTHER THAN THE LEVEL OF EXIT DISCHARGE UNTIL EXIT DISCHARGE IS ACCOMPLISHED FOR
- BUILDINGS REQUIRED TO HAVE TWO OR MORE EXITS. D. INTERIOR EXIT DISCHARGE ELEMENTS, AS PERMITTED IN SECTION
- 1027.1, IN BUILDINGS REQUIRED TO HAVE TWO OR MORE EXITS.
- DISCHARGE DOORWAYS IN BUILDINGS REQUIRED TO HAVE TWO OR 13. THE EMERGENCY POWER SYSTEM SHALL PROVIDE POWER FOR A

E. EXTERIOR LANDINGS, AS REQUIRED BY SECTION 1008.1.5, FOR EXIT

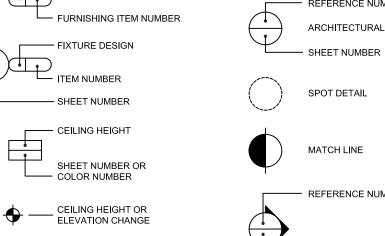
- DURATION NOT LESS THAN 90 MINUTES AND SHALL CONSIST OF STORAGE BATTERIES, UNIT EQUIPMENT AR AN ON-SITE GENERATOR. THE INSTALLATION OF THE EMEGENCY POWER SYSTEM SHALL BE IN ACCORDANCE WITH SECTION 2702. 14. EMEGENCY LIGHTING FACILITIES SHALL BE ARRANGED TO PROVIDE INITIAL ILLUMINATION THAT IS AT LEAST AN AVERAGE OF 1
- FOOT-CANDLE (11 LUX) AND A MINIMUM AT ANY POINT OF 0.1 FOOT CANDLE-(1 LUX) MEASURED ALONG THE PATH OF EGRESS AT FLOOR LEVEL ILLUMINATION LEVELS SHALL BE PERMITTED TO DECLINE TO 0.6 FOOT-CANDLE (0.6 LUX) AVERAGE AND A MINIMUM AT ANY POINT OF 0.06 FOOT-CANDLE (0.6 LUX) AT THE END OF THE EMERGENCY LIGHTING TIME-DURATION. A MAXIMUM-TO-MINIMUM ILLUMINATION UNIFORMITY RATIO OF 40 TO 1 SHALL NOT BE EXCEEDED.
- STUCH DRAFT STOPS MUST BE INSTALLED SO THAT THE AREA OF THE CONCEALED SPACES DOES NOT EXCEED (3,000) SQUARE FEET
- C. DRAFT-STOPPING MATERIALS MUST NOT BE LESS THAN 1/2-INCH GYPSUM BOARD, 3/8-INCH PLYWOOD, 3/8-INCH TYPE 2-M PARTICLE BOARD OR OTHER MATERIALS APPROVED BY THE BUILDING DEPARTMENT. DRAFT-STOPPING MUST BE ADEQUATELY SUPPORTED
- 16. FIRE BLOCKING MUST BE APPROVED IN ACCORDANCE WITH SECTION 717 AT THE FOLLOWING LOCATIONS:
- A. IN CONCEALED SPACES OF STUD WALLS AND PARTITIONS, INCLUDING
- FURRED SPACES, AT THE CEILING AND FLOOR LEVELS. B. IN CONCEALED SPACES OF STUD WALLS AND PARTITIONS, INCLUDING

FURRED SPACES, AT 10-FOOT INTERVALS ALONG THE LENGTH OF

 AT ALL INTERCONNECTIONS BETWEEN CONCEALED VERTICAL AND HORIZONTAL SPACES SUCH AS OCCUR IN SOFFITS, DROP CEILINGS, AND COVE CEILINGS.

EXISTING FLOOR SLAB TO BE DEMOLISHED

COMPLY WITH APPLICABLE LOCAL, STATE AND FEDERAL CODES AND REGULATIONS PERTAINING TO SAFETY OF PERSONS, PROPERTY AND ENVIRONMENTAL PROTECTION.



— INTERIOR FLOOR

---- ITEM NUMBER (FROM DECORATOR)

----- WALL FINISH

L---- ITEM NUMBER

FINISH OR MATERIAL

--- REFERENCE NUMBER

	7. REMOVE ABANDONED HVAC EQUIPMENT, INCLUDING DUCT WORK.
	8. REMOVE ABANDONED ELECTRICAL, TELEPHONE AND DATA CABLING OTHERWISE NOTED
L——— SHEET NUMBER	
ELEVATION REFERENCE	9. REMOVE EXISTING FLOOR FINISHES AND PREPARE SUBFLOOR AS

8. REMOVE ABANDONED ELECTRICAL, TELEPHONE AND DATA CABLING AND DEVICES, UNLESS

9. REMOVE EXISTING FLOOR FINISHES AND PREPARE SUBFLOOR AS REQUIRED FOR NEW FLOOR

. PROVIDE AND MAINTAIN BARRICADES, LIGHTING AND GUARDRAILS AS REQUIRED BY APPLICABLE

ERECT AND MAINTAIN DUSTPROOF PARTITIONS AS REQUIRED TO PREVENT SPREAD OF DUST,

FUMES AND SMOKE, ETC. TO OTHER PARTS OF THE BUILDING. ON COMPLETION, REMOVE

4. IF DEMOLITION IS PERFORMED IN EXCESS OF THAT REQUIRED, RESTORE EFFECTED AREAS AT

5. REMOVE FROM SITE DAILY AND LEGALLY DISPOSE OF REFUSE, DEBRIS, RUBBISH AND OTHER

6. REMOVE DESIGNATED PARTITIONS, COMPONENTS, BUILDING EQUIPMENT AND FIXTURES AS

CODES AND REGULATIONS TO PROTECT OCCUPANTS OF BUILDING AND WORKERS.

PARTITIONS AND REPAIR DAMAGED SURFACES TO MATCH ADJACENT SURFACES.

ISSUE/REVISION

<u>OWNER</u>

FRAN CAMAJ

M.E.P. ENGINEER

CIVIL ENGINEER

LIGHTING DESIGNER


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L ITEM NUMBER

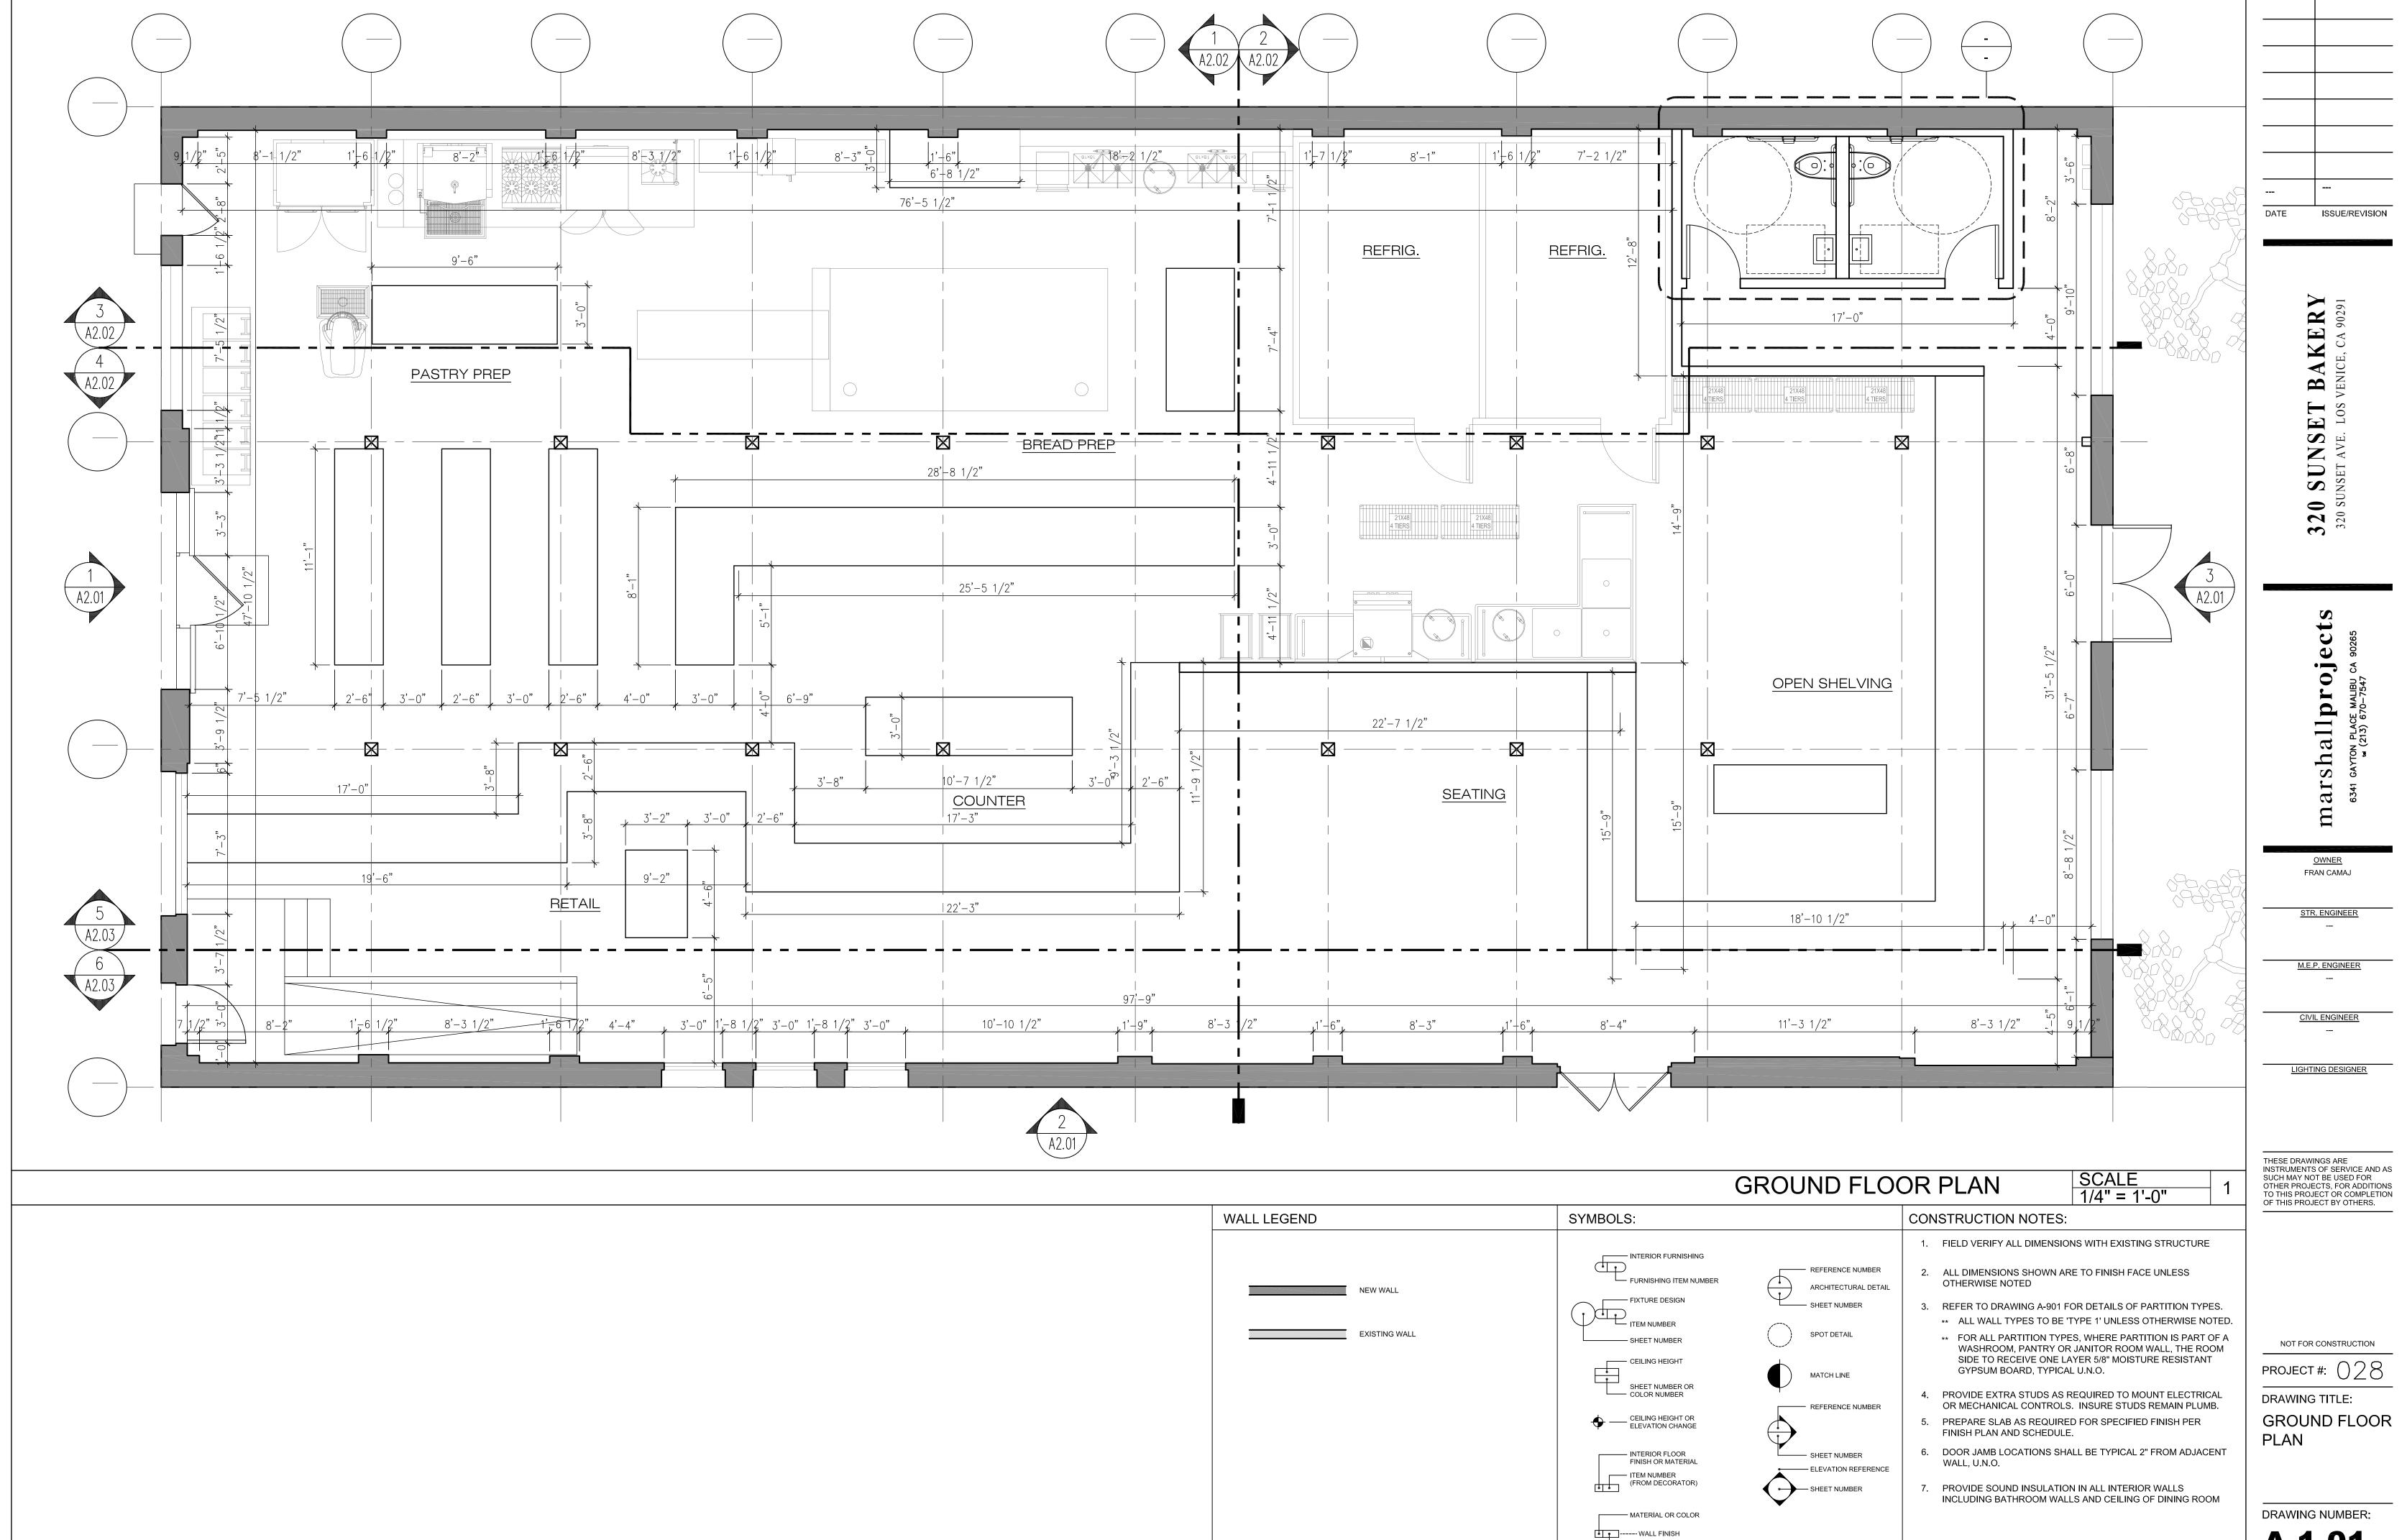A-1.01

